




PLAN  
SCALE: 1:40

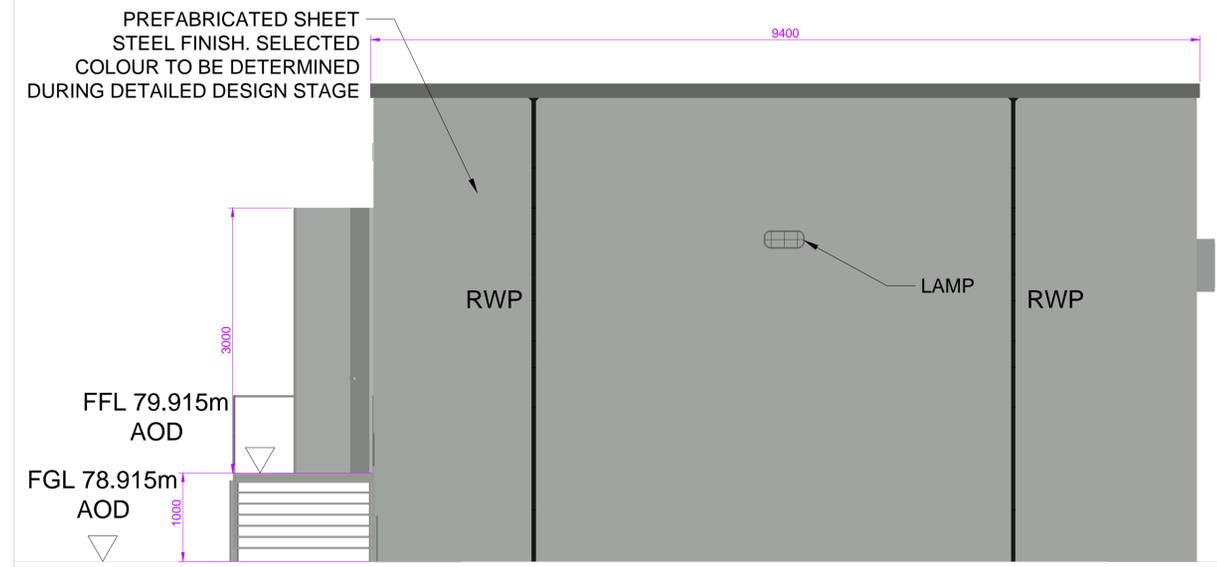


WEST ELEVATION  
SCALE: 1:40

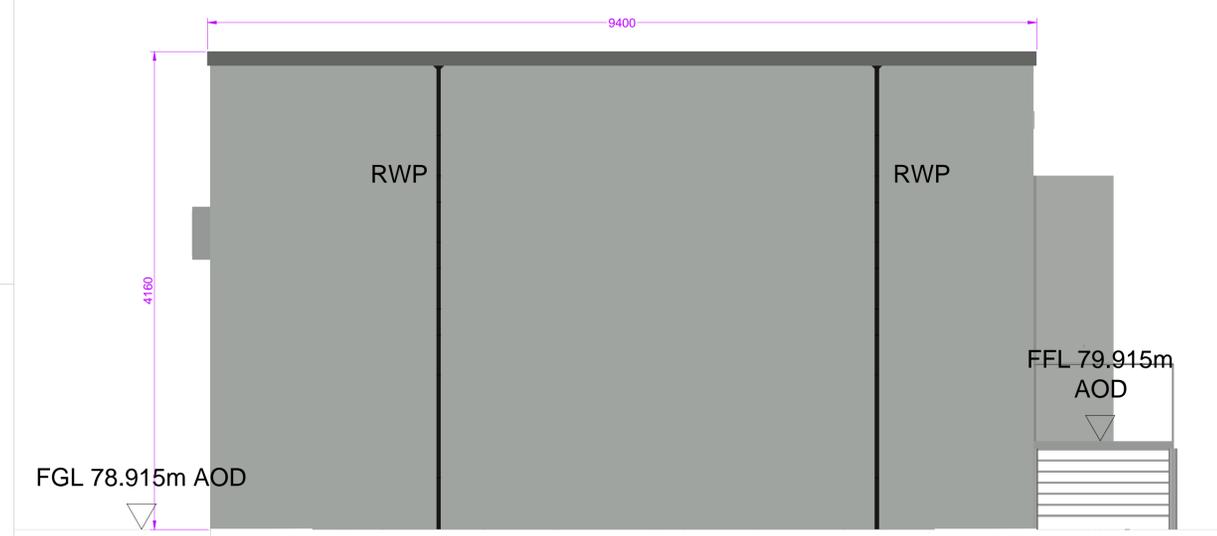


EAST ELEVATION  
SCALE: 1:40

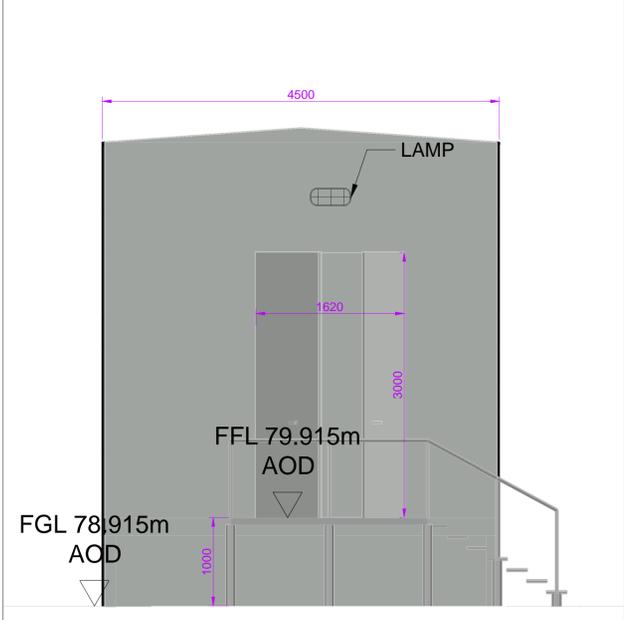

NORTH ELEVATION  
SCALE: 1:40

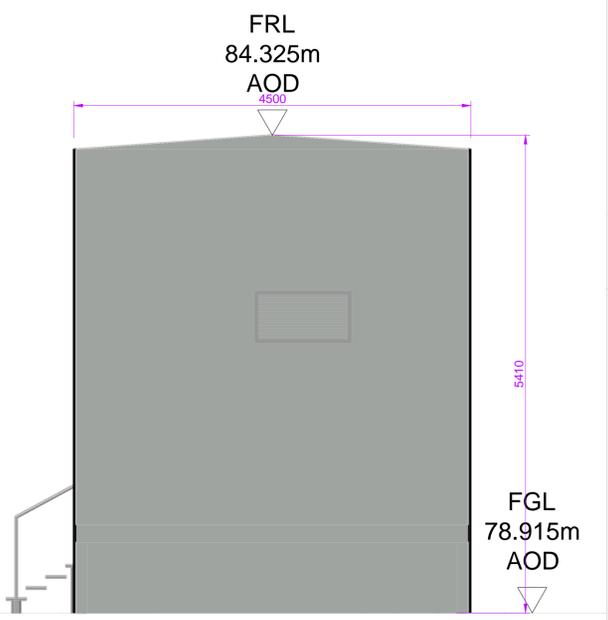

SOUTH ELEVATION  
SCALE: 1:40

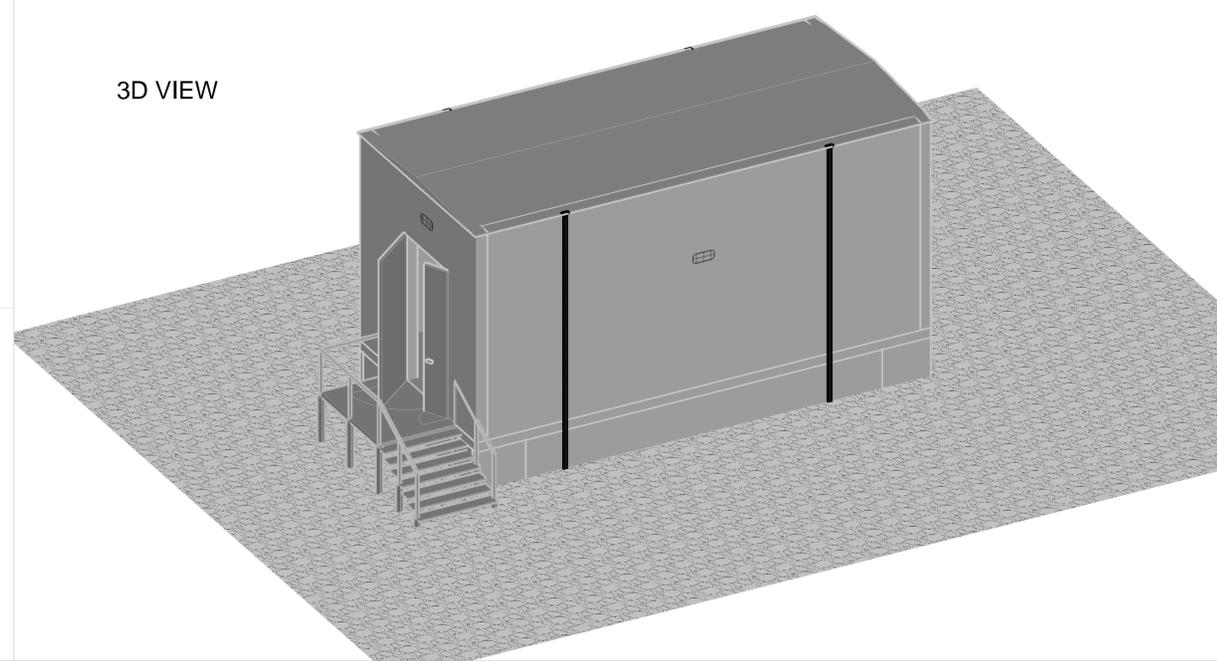

3D VIEW

**LEGEND**

**NOTES**

1. DRAWINGS ARE INDICATIVE ONLY AND SHOULD NOT BE USED FOR DETAILED DESIGN;
2. THE EQUIPMENT LAYOUTS ARE INDICATIVE AND DIMENSIONS MAY CHANGE ONCE THE EXACT SPECIFICATIONS ARE DETERMINED;
3. NORTH CARDINAL DIRECTION ACCORDING TO PROPOSED ORIENTATION IN SUBSTATION LAYOUT DOCUMENT REFERENCE 60641561-DWG-701.

**ISSUE/REVISION**

NO.	DATE	DESCRIPTION
P4	03/09/2021	FOR PLANNING
P3	30/07/2021	REVISED COMMENTS
P2	28/06/2021	REVISED COMMENTS
P1	11/05/2021	CLIENT COMMENTS
P0	16/04/2021	FIRST ISSUE FOR PLANNING
I/R	DATE	DESCRIPTION

**STATUS**  
**FOR PLANNING**

PROJECT NUMBER 60641561 SCALE 1:40 @ A1

SHEET TITLE  
MOORETOWN 220 kV SUBSTATION  
MV SWITCHGEAR CONTAINER  
LAYOUT, ELEVATIONS & 3D VIEW

SHEET NUMBER 60641561-DWG-709 REV P4

This drawing has been prepared for the use of AECOM's client. It may not be used, modified, reproduced or relied upon by third parties, except as agreed by AECOM or as required by law. AECOM accepts no responsibility, and denies any liability, whatsoever, to any party that uses or relies on this drawing without AECOM's express written consent. Do not scale this document. All measurements must be obtained from the stated dimensions.